

Waitai Coastal-Burwood-Linwood Community Board MINUTES ATTACHMENTS

Monday 8 September 2025

3.35 pm

Date: Time:

Ven	ue: Boardroom, Corner Beresford and Union Streets, New Brighton				
TAB	ABLE OF CONTENTS NGĀ IHIRANGI PAGE Public Forum - Spokes Canterbury A. Spokes Presentation				
4.2.		3			
5.1.	Deputations by Appointment - Five Under Parr A. Five Under Par Presentation	1			
5.5.	Deputations by Appointment Ngā Huinga Whakaritenga Cypress Garden/Bromley Old School Reserve – Park Improvements and Renewals OCSA - Bromley Skate Pamp Penewal presentation) 1			







Spokes Spokes Canterbury 'as Cycling Priorit **Spokes Cycling Priorities** Waitai

Coastal, Burwood, Linwood 8 September 2025

Anne Scott, Spokes Submissions Coordinator Stephen Wood, Spokes Newsletter Editor



Spokes held an open planning day at Tūranga in March

- 187 suggestions 14 specific to Waitai area
- Prioritised for each Community Board
- Safety and smaller connections that will enhance cycling
- Top three and general priorities today, but hope to present the remaining ideas in the future
- We also looked at the Love-to-Ride data entered by participants

Strategic Priorities






MCR New Brighton to City - Pages Road

- Lot of support for Pages Road MCR as direct route for commuter and school travel
- City to Sea is recreational rather than direct
- Could be done cheaply as a trial on Pages Road using the techniques from Park Terrace, however permanent solution is best and cheapest longer term
- Preferred route Pages / Woodham / Worcester finishing at England St - 5.2km (not Avonside Drive route suggested in some docs)
- Starts from Anzac Drive assuming rest is in Bridge Replacement Project
- Start building from New Brighton end
- Rename Pages Rd MCR to avoid confusion

Waitai – Priority 1

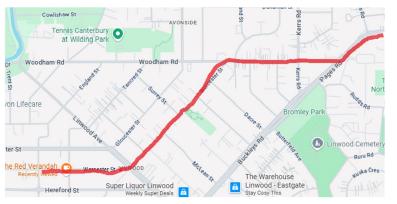





Prestons / Marshland Intersection

- Cyclists travelling west on Prestons Road through Marshland Road intersection being cut off by traffic turning left into Marshland Road, BP and shops
- Shared path by BP + pedestrian crossing provide cut down to encourage use
- Red left turn light is available but does not trigger for cyclists, particular concern at night
- Vehicles turning north from Prestons do not see cyclists going straight through (east)
- Ask staff to review intersection safety and recommend improvements for cyclists
- Re-establish off road cycle lane on Prestons Road - increasingly popular route going to Hills Road underpass or to Redwood
- Talked to Waipapa as well as on boundary

Waitai – Priority 2









Rookwood Ave / Bowhill Road / Travis Road

- Rookwood / Bowhill important missing link between QEII Drive/Travis Rd and Marine Parade
- Avonside Girls, Shirley Boys, and Rawhiti schools
- Drivers travelling too fast, passing too close to cyclists
- Ideally separated cycleway linking QEII Path with Marine Parade but painted lines would help
- Look at safety options to reduce speeds and move cars closer to the centreline
- Improve roundabout Rookwood / Keyes / Bowhill
- Road surface on Bowhill is rough where cyclists travel

Waitai – Priority 3







Waitai – Priority 4-6

- Widen and improve safety at 2 refuge crossings on Rutherford St, Woolston, each side of bridge over Heathcote – crossings on both sides of bridge popular with cyclists and pedestrians – fast traffic, risky behaviour, poor sight lines over bridge
- Keyes Road needs cycle lanes, better lighting, and some traffic calming
- Avonside Drive / Woodham Road / Linwood Ave intersection difficult for cyclists and pedestrians to cross. School buses also having problems. Change intersection to roundabout that is friendly for pedestrians and concerned cyclists (aka Dyers Pass / Cashmere / Colombo)

Waitai – Priority 4-6







General Priorities



- Bike parking at popular destinations and events that suits a wide range of bikes with space for loading and unloading
- Provision of cut downs into and out of paths suitable for cargo bikes and mobility devices
- More cycle signage and way-finding
- Reinstating cycle infrastructure when road works done
- Improved lighting for cycling through parks and alleyways
- Greater enforcement for vehicles parked / driving in cycleways
- Detectors in cycle lanes at traffic signals
- Flexi-posts alongside on-road cycle lanes, to remind drivers not to drive in the cycle lane
 on left hand bends and at intersections (e.g. near UC)



Recommendations

Ask staff to:

- Report on progress on the Pages Road MCR, including the route selected
- Review the Prestons Road / Marshland Road intersection for safety and recommend improvements for cyclists
- Review Rookwood Ave / Bowhill Road / Travis Road to improve safety for cyclists
- Report on advice provided for the eastern orbital









North Elevation



Proposed Exterior Colours / Materials

The proposed driving range development is located at the northern end of the site, with buildings arranged in a wing formation. A centrally positioned two-level gable building will accommodate sales, administration, and storage functions. This structure provides the axis from which the driving range bays extend in an east–west orientation.

The driving bays will be constructed using a painted steel frame with a monopitch roof. Ancillary buildings are integrated into the bay wings and adopt the same roof form. The arrangement of built forms responds to functional requirements. While the overall floor plan is substantial, the vertical profile maintains a modest scale on the site.


External materials comprise Coloursteel roof and wall cladding in the selected profile. This material is widely used in New Zealand for its durability and low maintenance requirements. A neutral colour palette of contrasting light and dark tones will be applied to reduce the visual impact. The entry and interior spaces will include accent colours to assist with wayfinding and to provide visual interest. Aluminium window joinery will be used with colour selection and shrouds providing additional variation and contrast.

To the northern elevation of the driving bays, translucent polycarbonate cladding is proposed. This will maximise natural light during the day, and at night, internal illumination will create a subtle lantern effect.








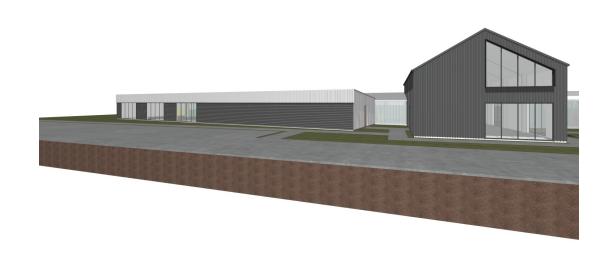



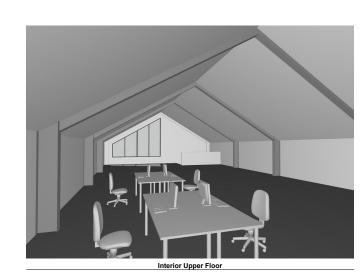











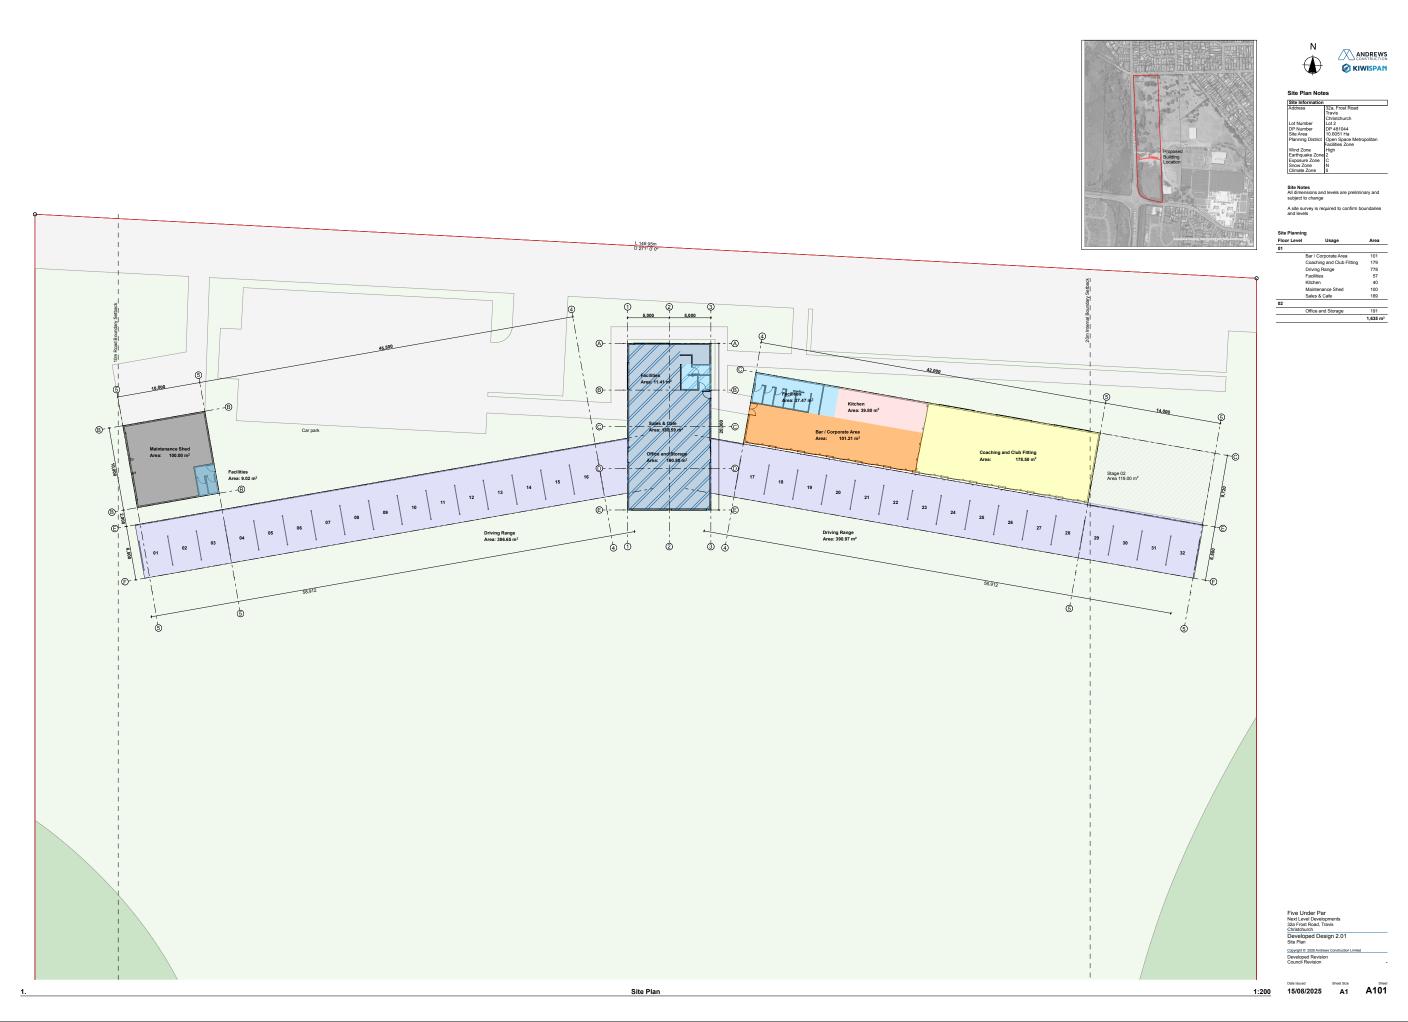

Christchurch City Council

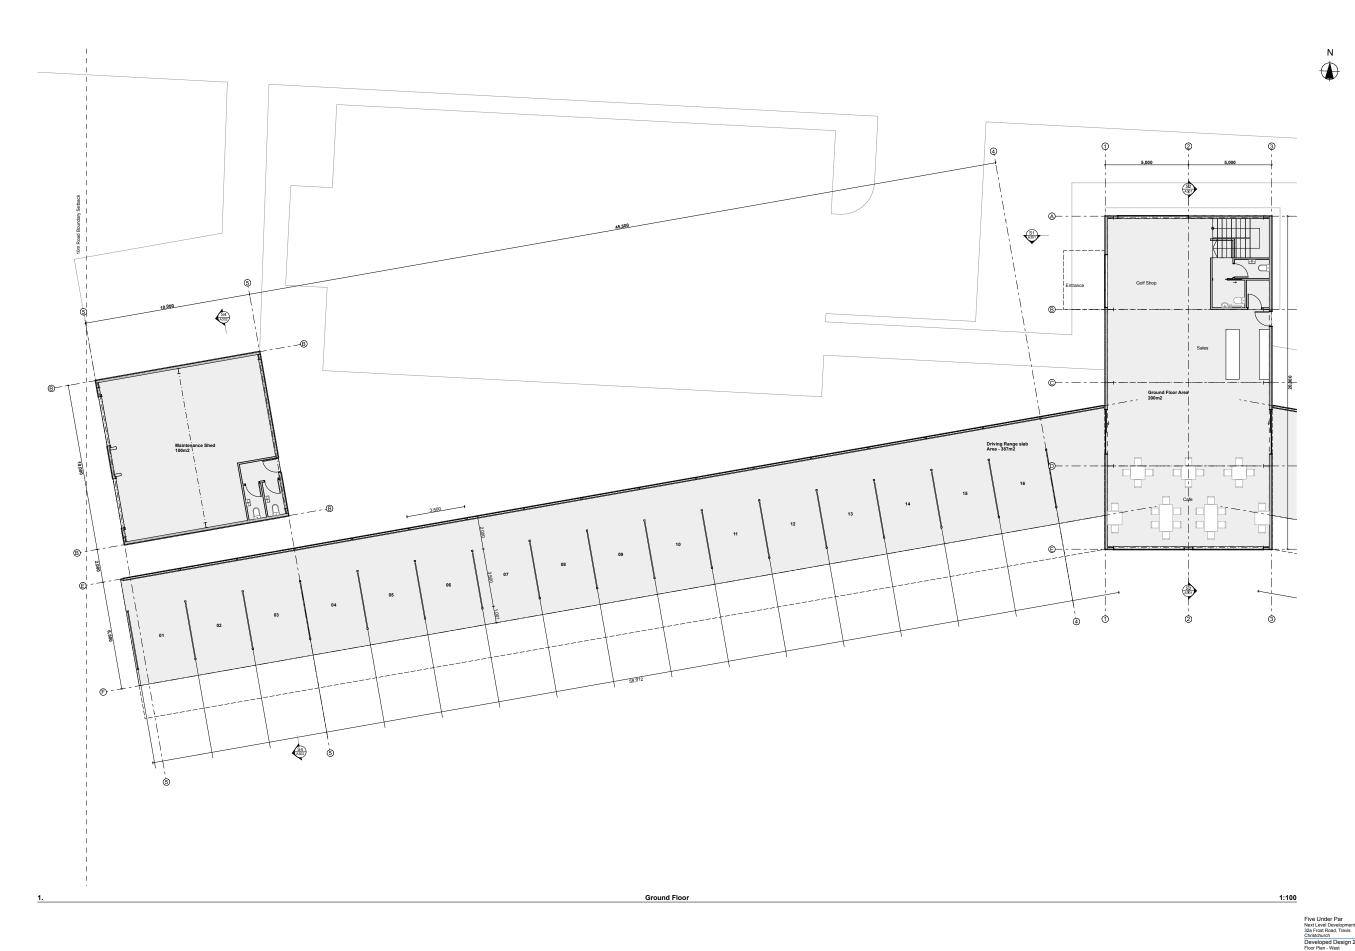

Copyright © 2005 Andreas Construction Limited
Developed Revision
Council Revision

Date Issued Sheet Size

15/08/2025 A1 A104



















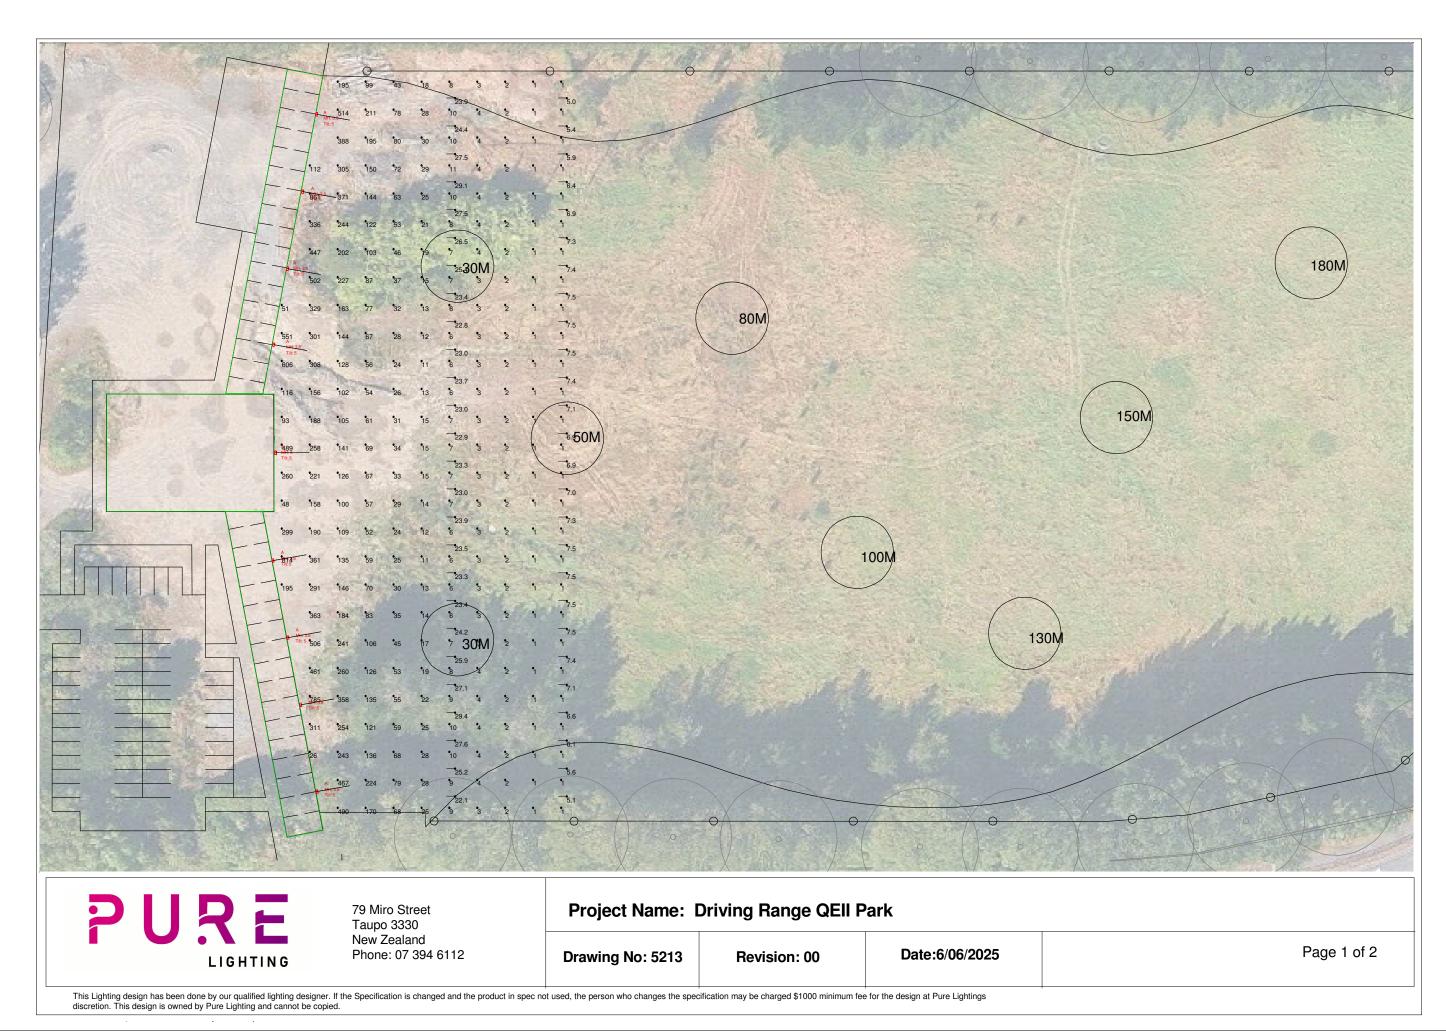

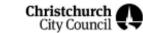

Luminaire Schedule & Calculation Summary

Luminaire Schedule										
Symbol	Qty	Label	Description	LLF	Luminaire					
					Watts					
	9	Α	PLSFL600-F22004+H80 semi cutoff 600w flood	0.900	598.819					

Calculation Summary									
Project: Driving range	t: Driving range								
Label	Units	Avg	Max	Min	Min/Avg	Min/Max			
30m mark vertical at 1m	Lux	24.81	29.4	22.1	0.89	0.75			
50m mark vertical at 1m	Lux	6.82	7.5	5.0	0.73	0.67			
fairway horizontal	Lux	81.17	861	1	0.01	0.00			

No full plans or specification viewed.

Pre-curfew obtrusive calculations (to be verified by Christchurch Council);

Maximum allowable boundary illuminance 4 lux.

Maximum allowable luminous intensity 12,500 cd.

Maximum alloable TI on roads 20%.





79 Miro Street Taupo 3330 New Zealand Phone: 07 394 6112 Project Name: Driving Range QEII Park

Drawing No: 5213

Revision: 00

Date:6/06/2025

Page 2 of 2

This Lighting design has been done by our qualified lighting designer. If the Specification is changed and the product in spec not used, the person who changes the specification may be charged \$1000 minimum fee for the design at Pure Lightings discretion. This design is owned by Pure Lighting and cannot be copied.



FIVE UNDER PAR LTD

PROPOSED DRIVING RANGE QEII PARK

MM / SK FROSTS ROAD / TRAVIS ROAD DESIGN DRAWN MM CHECKED MM / SK APPROVED MM / SK

SCALE 1:1000@A3 REV COUNCIL Christchurch City Council **4B** Preliminary Site Plan.dwg DWG NO







OTAUTAHI CHRISTCHURCH SKATEBOARD ASSOCIATION



Cypress Gardens Skate Ramp Renewal, Bromley

- Will Bartlett Otautahi Skateboard Association, Chairperson
- Damian Doyle Skateboarding New Zealand, 44 Ramps


Our Purpose:

- Offer CCC staff and community board members sound advice and guidance regarding skate space designs and ideas
- Skatepark quality and maintenance solutions, utilising industry knowledge and experience
- · Futureproof, grow and promote skateboarding in the city
- · Assist with genuine engagement and feedback from the wider community and park users city wide
- Guardians of the skateparks





SKATE SPACES - A DELICATE BALANCE OF PARK USERS, SKILLS AND ASPIRATIONS

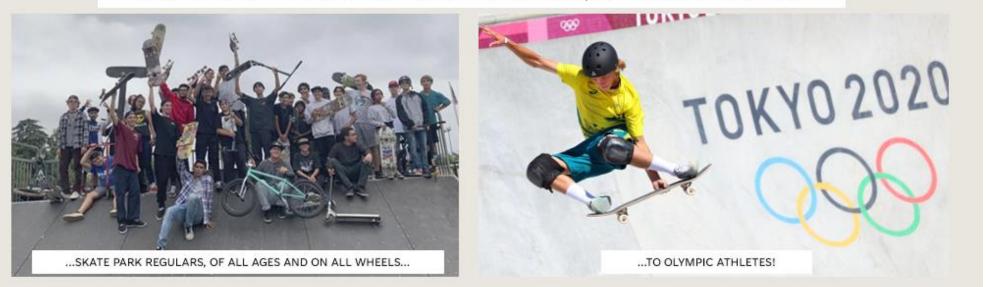

THE PROPOSED PLAN

- We support a new facility **WITH** tweaks and **meaningful input from users**.

OUR CONCERNS

- Insufficient budget for a replacement ramp of adequate scale and useability
- Losing a significant ramp for the wider Christchurch skatepark users
- That the mentioned "balancing [loss of Bromley Ramp] by incorporating a similar ramp element when the nearby Linwood Park skate park is renewed" won't occur.
- The overall budget isn't balanced between ramp renewal (\$85k) and new pump track upgrade (\$120k)

HOW YOU CAN ADDRESS OUR CONCERNS

- Genuine ongoing consultation between our association and project staff regarding the new facility
- The new ramp design and build being of comparable nature in terms of scale and budget
- A feeling of the ramp being RENEWED/UPGRADED rather than DOWNGRADED
- Consideration for a renovation of the current ramp rather than its demolition, as supported by the petition
- Evaluating the size of the "pump track upgrade" and "skate ramp renewal" budgets
- Working with a local company to deliver the best ramp quality, value and to meet the end users requirements







POTENTIAL SOLUTIONS

1.


- Refurbish the original ramp. circa \$7-10k to retain the advanced skating/bmx element.
- A smaller beginner/intermediate ramp as proposed may then be more palatable to local skaters

2.


- Build a ramp that is comparable to the legacy of the current one,
 a new ramp that is worthy of removing the old ramp
- We're very lucky to have someone local, Damian Doyle of 44 Ramps, kindly produce concept designs free of charge to show you what could be possible
- Budget tweaks may be required

4




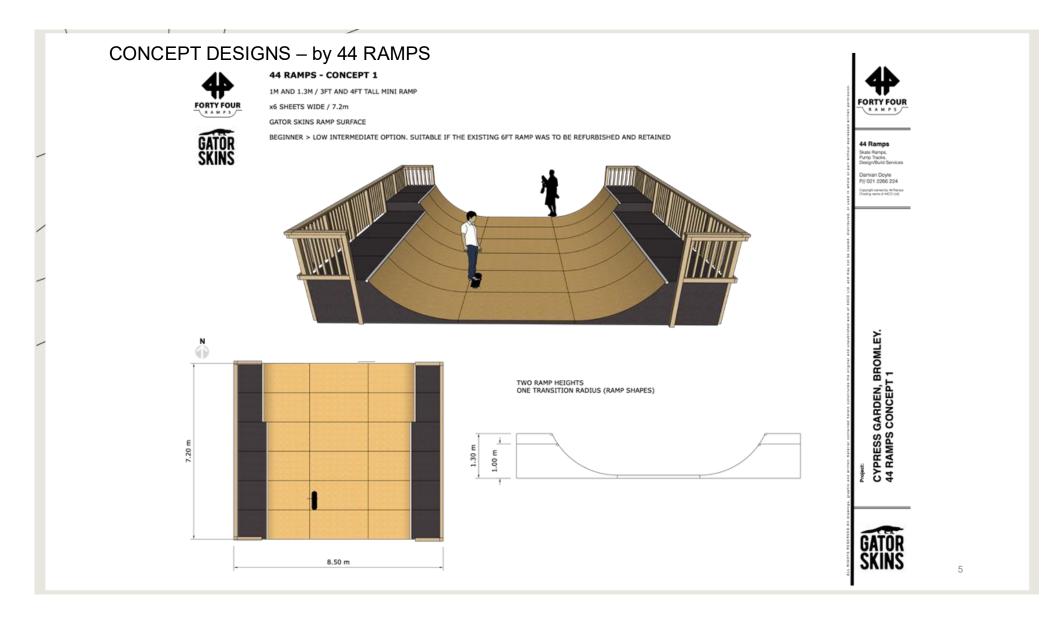



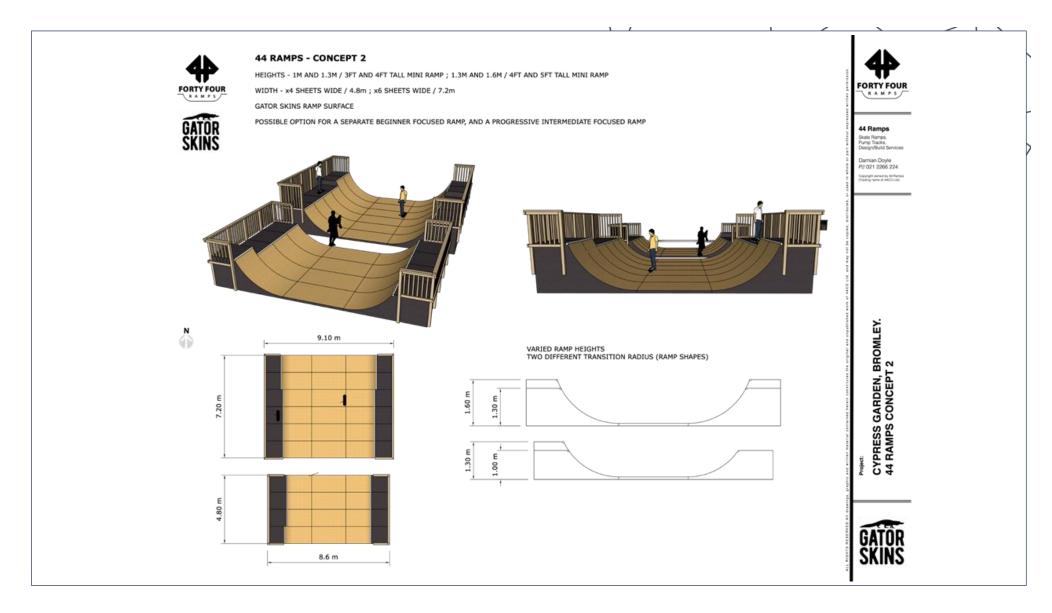



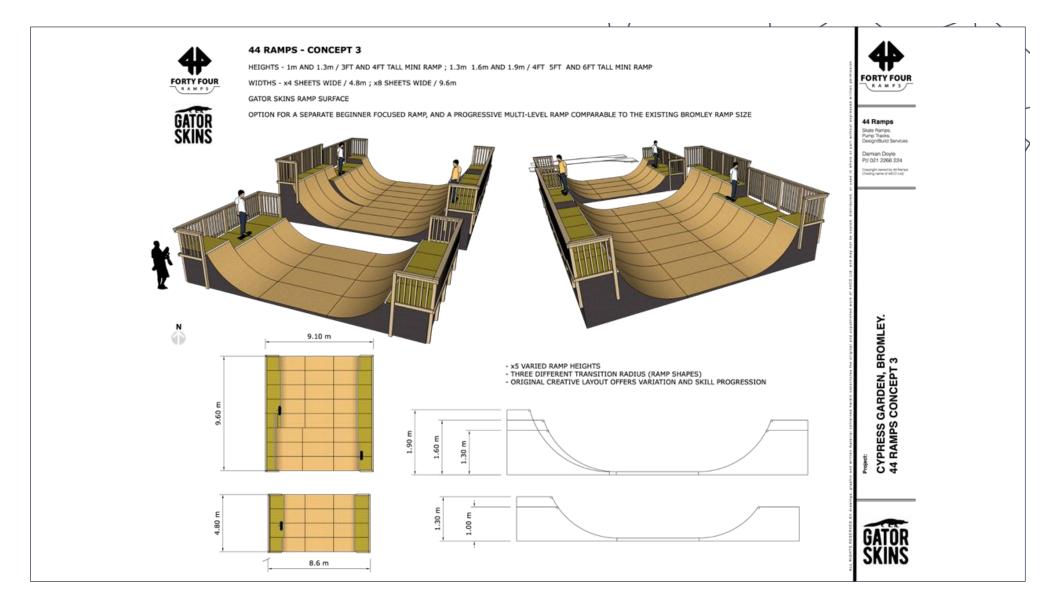



IN SUMMARY:

- We support a new ramp worthy of <u>replacing</u> the old one
- Don't wish to pause or hold up the process
- We would like it to feel like an <u>upgrade not a loss</u>
- Work with us and a local company

We welcome further questions, thank you.



8